

5/17/2017 3:19:22 PM

## LEGEND AND ABBREVIATIONS

1D AN	ID ABBREVIATIONS
ABBR	DESCRIPTION
	RECTANGULAR DUCTWORK (WIDTH X DEPTH)
	FLAT OVAL DUCTWORK
	SQUARE ELBOW W/ TURNING VANES
	RADIUS ELBOW
	SQUARE-THROATED TEE
	CHANGE IN ELEVATION (R=RISE, D=DOWN)
	TRANSITION WITH FLAT SIDE
	TRANSITION ON CENTER
	DUCT TRANSITION (SQUARE TO ROUND)
	ACCESS DOOR (SIDE OR BOTTOM LOCATION)
	SUPPLY AIR DUCT UP/DOWN
	RETURN/EXHAUST AIR DUCT UP/DOWN
	OUTDOOR AIR DUCT UP/DOWN
	EXIST PIPE (RL/RS, CHWS/R, ACD) TO BE REMO
	EXIST PIPE (RS/RL, CHWS/R, ACD) TO REMAIN
	NEW PIPE (RS/RL, CHWS/R, ACD)
	ELBOW, TURNED UP
	ELBOW, TURNED DOWN
	PIPE TEE, TURNED UP
	PIPE TEE, TURNED DOWN
	CONCENTRIC REDUCER
	ECCENTRIC REDUCER
	PIPE CAP
	FLANGED CONNECTION
	UNION CONNECTION

EXPANSION JOINT

FLEXIBLE PIPING


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## MECHANICAL GENERAL NOTES:


- 1. ALL MECHANICAL WORKS SHALL CONFORM TO THE 2009 EDITION OF THE INTERNATIONAL BUILDING CODE, 2009 EDITION OF THE INTERNATIONAL MECHANICAL CODE, THE CONTRACT DOCUMENTS AND THE RULES AND REGULATIONS OF THE GOVERNMENT OF GUAM AUTHORITIES HAVING JURISDICTIONS.
- 2. THE CONTRACTOR SHALL VERIFY FIELD CONDITIONS AND COORDINATE THE WORK AMONG VARIOUS TRADES AS NECESSARY TO AVOID CONFLICTS AND TO ENSURE THE PROPER INSTALLATION OF THE WORK WITHIN THE AVAILABLE SPACE.
- 3. THOUGH SOME OFFSETS AND TRANSITIONS ARE SHOWN IN PIPING AND DUCTWORKS TO HELP INDICATE THE PHYSICAL RELATIONSHIP BETWEEN THEM, IT IS NOT THE INTENT OF THE DRAWINGS TO SHOW ALL PIPING AND DUCTWORKS OFFSETS AND TRANSITIONS REQUIRED. THE CONTRACTOR SHALL COORDINATE THE MECHANICAL WORK WITHIN ITSELF AND THE WORK OF ALL TRADES TO PROVIDE COMPLETE AND OPERABLE SYSTEM WITHOUT INTERFERENCES.
- 4. LOCATION OF AIR INLETS AND OUTLETS ARE APPROXIMATE. REFER TO ARCHITECTURAL REFLECTED CEILING PLANS FOR EXACT LOCATIONS. WHEN MECHANICAL AND ARCHITECTURAL DRAWINGS SHOW CONFLICTING LOCATIONS, CONSULT WITH ARCHITECT.
- DIFFUSER, REGISTER AND GRILLE SIZES SHOWN ON FLOOR PLAN ARE NECK SIZES.
   COORDINATE ALL EQUIPMENT CONNECTIONS WITH MANUFACTURER'S CERTIFIED DRAWINGS.
   COORDINATE AND PROVIDE ALL DUCT AND PIPING TRANSITION REQUIRED FOR FINAL
   EQUIPMENT CONNECTIONS TO FURNISHED EQUIPMENT. VERIFY AND COORDINATE ALL DUCT AND
   PIPING DIMENSIONS BEFORE FABRICATION.
- 7. PROVIDE VIBRATION ISOLATION FOR ALL MECHANICAL EQUIPMENT TO PREVENT TRANSMISSION OF VIBRATION TO BUILDING STRUCTURE.
- 8. CONTRACTOR SHALL ENSURE THAT MECHANICAL EQUIPMENT IS INSTALLED WITH MANUFACTURER'S RECOMMENDED ACCESS SPACE AND TO MEET THE NATIONAL ELECTRIC CODE
- CLEARANCES.

  9. SUBMIT LEVEL CONTROL AND ALARM SEQUENCE PLAN FOR GWA REVIEW AND APPROVAL PRIOR TO INSTALLATION AND PROGRAMMING INTO CONTROLLER. PROVIDE POSTED INFORMATION AND
- INSTRUCTIONS AT THE STATION AT COMPLETION OF THE PROJECT.

  10. CONTRACTOR TO FIELD VERIFY PRIOR PROGRAMMING THE ELEVATIONS, ADJUST AS NEEDED AND TO DEMONSTRATE TO GWA THE EFFECTIVENESS OF THE PROPOSED ELEVATIONS USING LEVEL CONTROLS PRIOR TO TURN-OVER.
- 11. NEW CONTROLLER SHALL HAVE SPRING-LOADED "M-O-A" (MANUAL-OFF-AUTO) SWITCH FOR ALL PUMPS TO ALLOW MANUAL STARTING AND SHUTTING DOWN OF EACH PUMP. THE SPRING MECHANISM SHALL PREVENT THE OPERATOR FROM INADVERTENTLY LEAVING THE PUMP ON MANUAL
- 12. PROVIDE ENOUGH SLACK FOR LEVEL TRANSMITTER AND FLOAT LEVEL SWITCH CABLES. INSTALL FLOAT LEVEL SWITCH HANG IMMERSED IN THE LIQUID.
- 13. SET HEIGHT OF FLOAT LEVEL SWITCHES AND TRANSDUCER AT WET WELL DURING COMMISSIONING OF THE PUMP CONTROLLER.
- 14. SET ELEVATION CONTROL POINTS AS SHOWN IN SEWAGE PUMP SEQUENCE OF OPERATION.

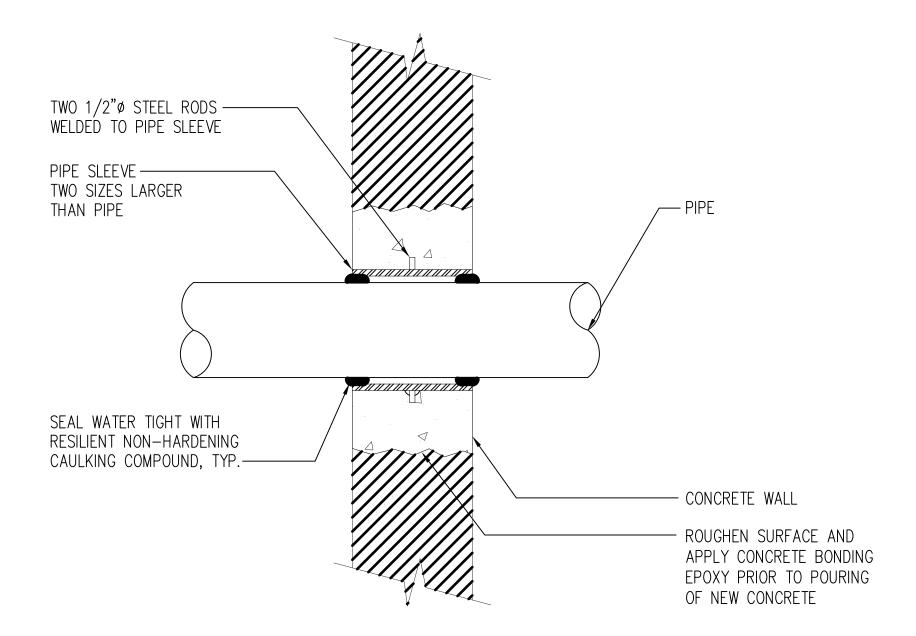

## PIPE THRU WALL DETAIL

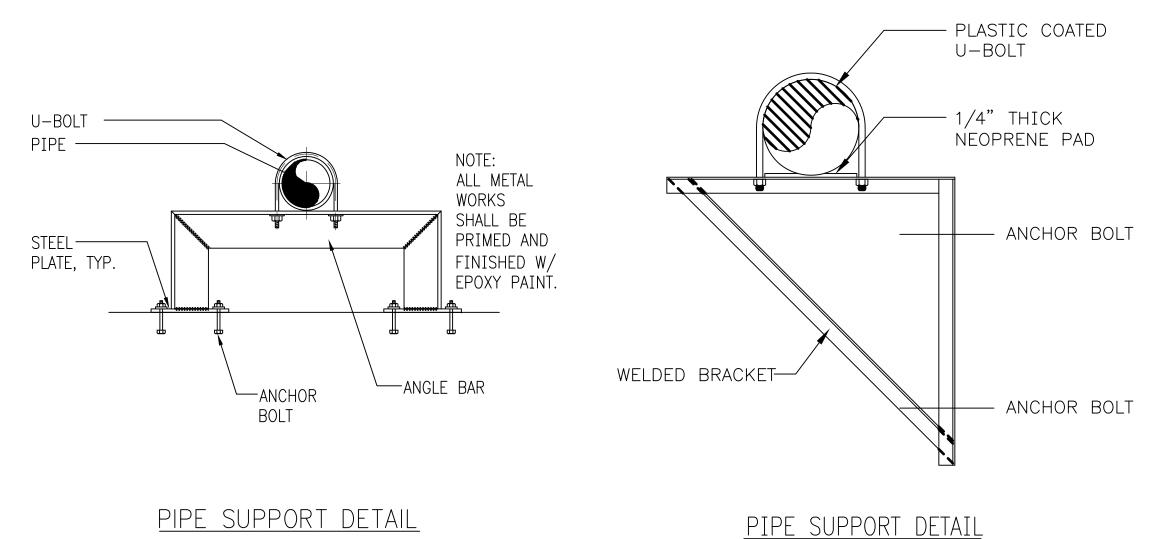




GRAPHIC SCALE:


EXHAUS	EXHAUST FAN SCHEDULE												
		SERVICE CAPACITY E.S.P. (CFM) (IN H2O)				MOTOR					WEIGHT		
MARK NO.	SERVICE			TYPE	CLASS	DRIVE	HP	RPM	VOLTS	PHASE	HERTZ	(LBS)	REMARKS
EF 1	PUMP HOUSE-LOWER FLOOR	900	0.5	BACKWARD INCLINED	-	BELT	1/4	1,750	115	1	60	120	SPARK RESISTANT WITH MANUAL CONTROL.

PUMP SCHEDULE										
MARK NO. LOCATION	TYPE	CAPACITY (GPM)	TOU			MOTOR				
			TDH (FT H20)	HP	RPM	VOLTS	PHASE	HERTZ	REMARKS	
P 1	WELL	SUBMERSIBLE NON-CLOG SEWAGE PUMP	350	60	10	1,750	460	3	60	- - -

EMPSCO Engineering Management & Planning Services Corporation  1998 ARMY DRIVE, 2/F EMPSCO BUILDING	)									
ROUTE 16, DEDEDO, GUAM 96929 Tel. (671) 638.5716 / 638.4716 Fax (671) 638.2136	REV	DATE	BY	DESCRIPTION	APPROVED BY					
	GWA NO.									
I HEREBY CERTIFY THAT THIS PLAN WAS PREPARED BY ME OR UNDER MY DIRECT SUPERVISION DATE:	GRANT ID	NO.		GUAM WATERWORKS AUTHORITY GOVERNMENT OF GUAM						
	CONTRACT	NO.		ENGINEERING DIVISION						
	PROJECT N	0.		BAYSIDE PUMP STATION REHABILITATION  CAMP WATKINS ROAD, TAMUNING, GUAM						
DES. BY: JBE	CHIEF ENG	R:		CONTENTS:	DRAWING NO.					
DRN. BY: JBE	ENGR. SUP	:		NOTES, DETAILS, SCHEDULES, LEGENDS  AND ABBREVIATIONS	M-0.1					
снк. ву: ЈВЕ	PROJ. ENG	R:		SHT.						

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## DEMOLITION KEYED NOTES:

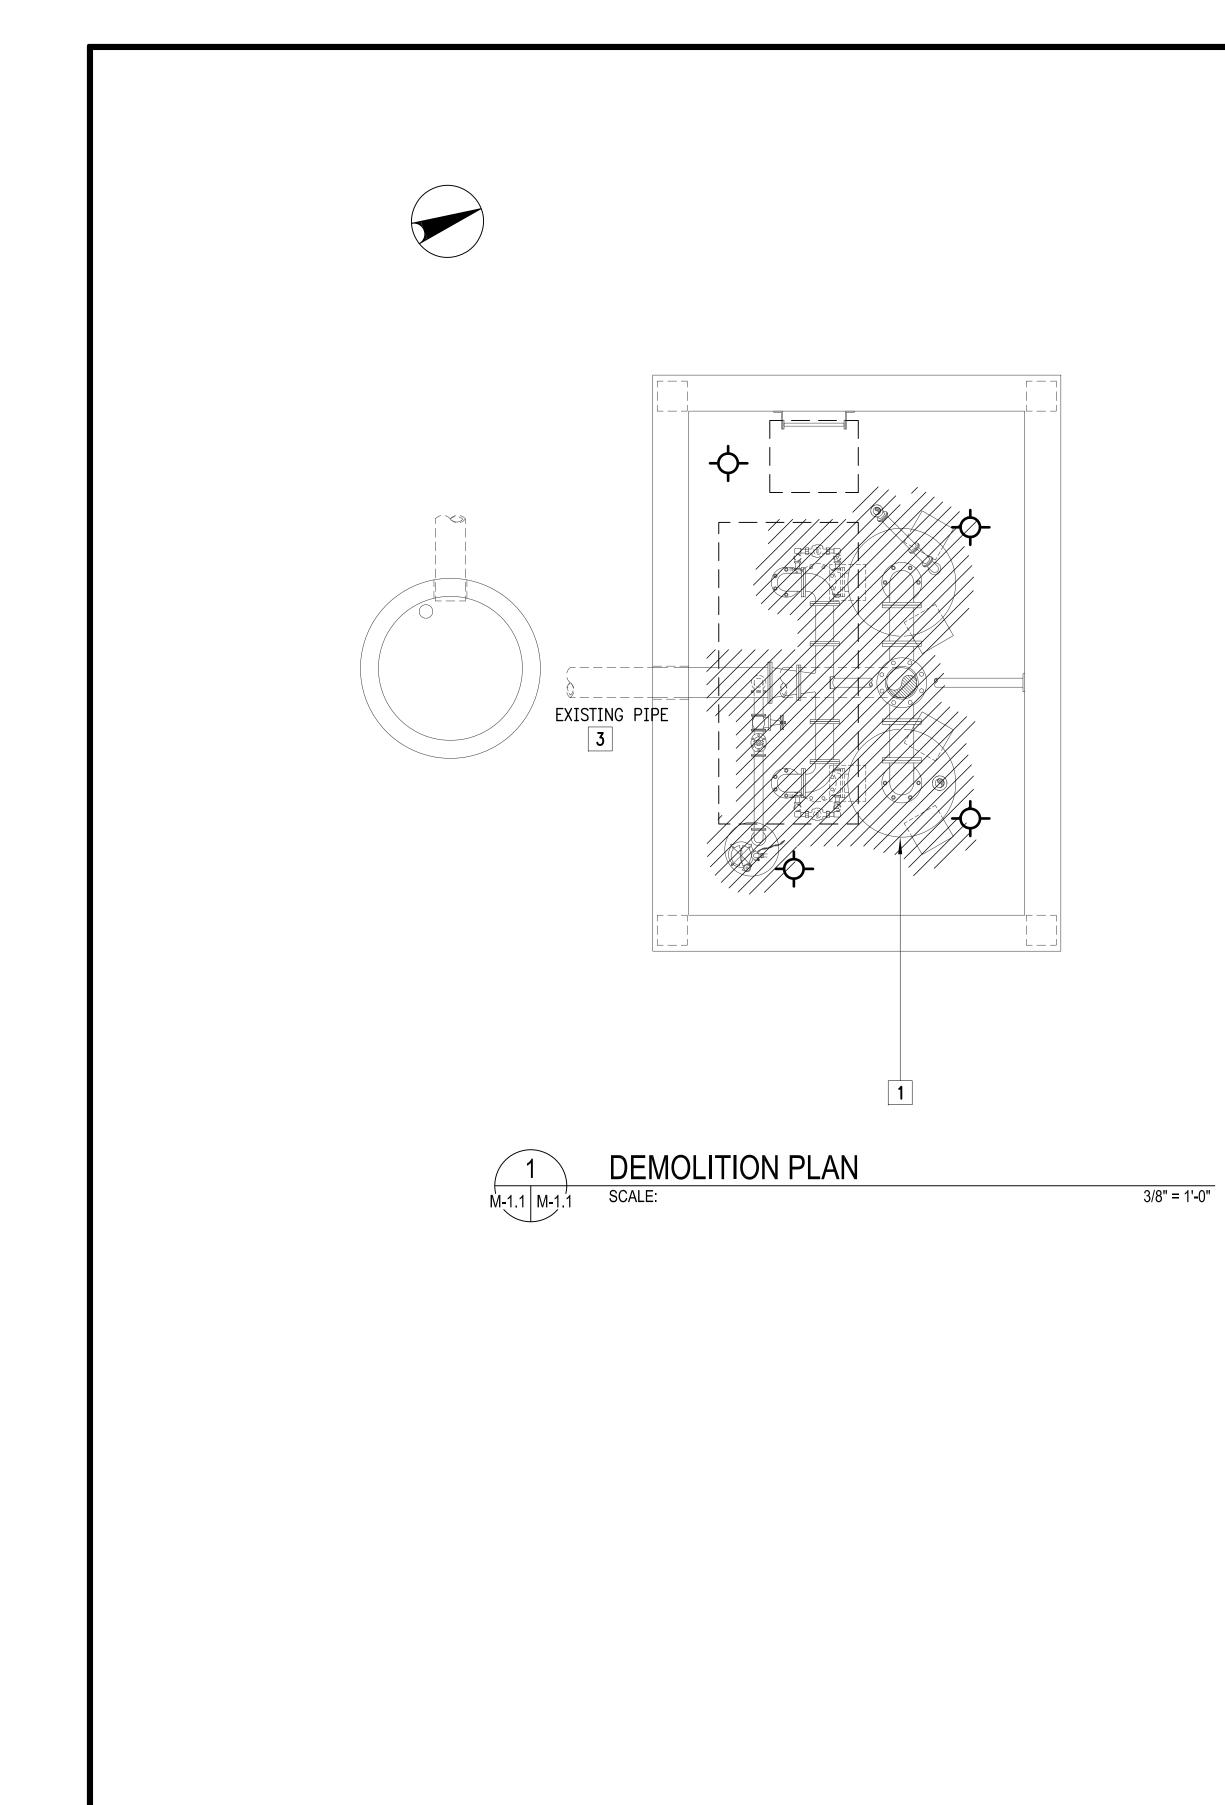- REMOVE AND DISPOSE EXISTING PUMP INCLUDING ASSOCIATED PIPES AND FITTINGS.
- REMOVE EXISTING SUBMERSIBLE PUMP, BY-PASS PIPING, VALVES AND FITTINGS. REMOVAL SHALL BE DONE AFTER THE NEW SEWAGE PUMPS, PIPES AND FITTINGS HAVE BEEN ACCEPTED BY GWA. TURN OVER PUMP, PIPES, VALVES AND FITTINGS TO AGANA MAINTENANCE YARD OR AS DIRECTED BY GWA.
- EXISTING EMBEDDED SECTION OF PIPE TO REMAIN; CLEAN INTERNAL DIRT AND DEBRIS, PROVIDE CCTV INSPECTION/DATA FOR GWA REVIEW. PROVIDE CIPP LINING INTO ENTIRE PIPE AFTER CLEANING.

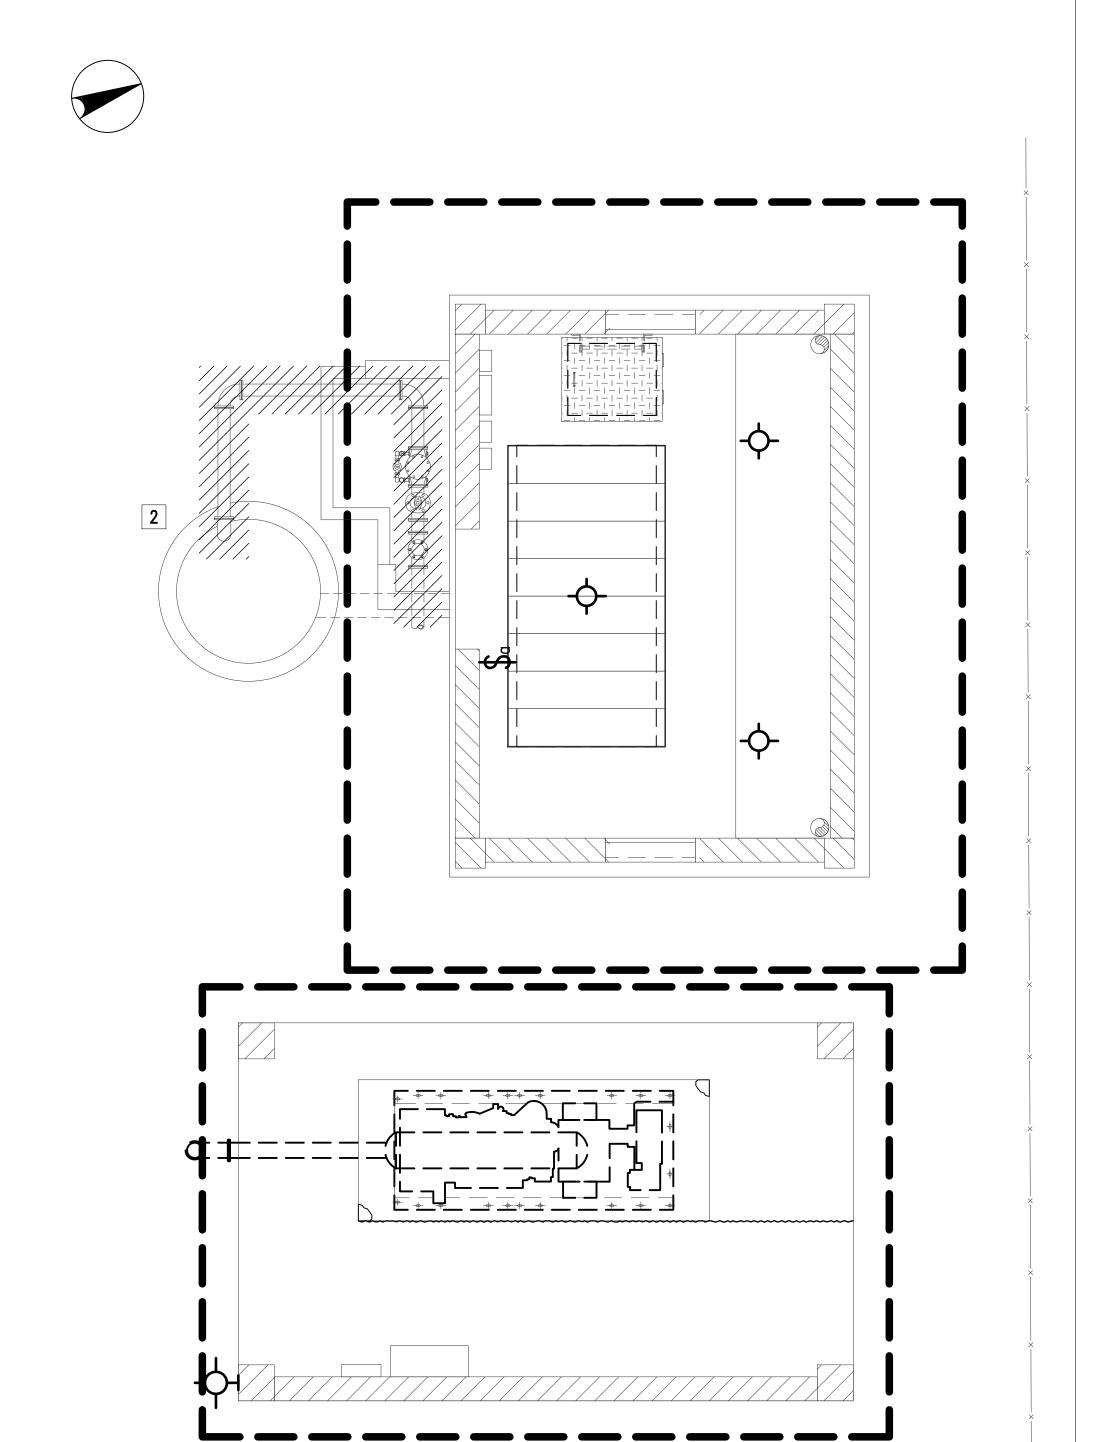DEMOLITION PLAN								
SCALE:	3/8" = 1'-0"							
	EMPSCO Engineering Management & Planning Services Corporat  1998 ARMY DRIVE, 2/F EMPSCO BUILDING ROUTE 16. DEDEDO, GUAM 96929	ion						
	ROUTE 16, DEDEDO, GUAM 99729  Tel. (671) 638.5716 / 638.4716 Fax (671) 638.21	REV DATE	BY	DESCRIPTION	APPROVED BY			
		GWA NO.						
		GRANT ID NO.  CONTRACT NO.		GUAM WATERWORKS AUTHORITY GOVERNMENT OF GUAM ENGINEERING DIVISION				
	I HEREBY CERTIFY THAT THIS PLAN WA: PREPARED BY ME OR UNDER MY DIREC' SUPERVISION  DATE:		į	PROJECT: BAYSIDE PUMP STATION REHA				
GRAPHIC SCALE:				CAMP WATKINS ROAD, TAM	1UNING, GUAM			
0' 1' 2' 4' 6' 8' 10'	DES. BY: JBE	CHIEF ENGR:		CONTENTS:	DRAWING NO.			
SCALE : 3/8" =	DRN. BY: JBE	ENGR. SUP:		DEMOLITION PLAN	M-1.1			
,	снк. ву: ЈВЕ	PROJ. ENGR:			SHT22_ OF _27			